landscape development application

Eleebana Shores - Seniors living retirement village development



drawing register

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SITE - GENERAL DESCRIPTION

The following landscape Design Report has been prepared in accordance with the requirements of Lake Macquarie City Council Development Control Plan No.1 and Local Environment Plan

The site consists of two lots, is located on the eastern side of Burton Road. Mount Hutton and comprises an area of approximately 4.959 hectares. Lot 1 consists of a single storey residence with pool, horse paddocks and associated sheds. Lot 12 also contains a single storey residence, with additional sheds, horse paddocks and training yards extending further eastward than Lot 1. The majority of the site occurs within the 1(2) Rural (Living) Zone, whilst an approximate third of the site adjoining the eastern boundary is zoned 7(5) Environmental (Living). The Mount Hutton Area Plan identifies the site as being located within the Casson Avenue Precinct and as such is mainly characterised as "bushland and rural housing.". Its location affords distant views to vegetated hillsides and ridgelines to the south and west, whilst the site itself is bounded by small acerages to the north, east and south and Burton Road to the west, with more small acerages further westward. Ducks Crossing Restaurant is located to the sites immediate south. Refer to Viewpoint Location Plan for an indication of the ratio of developed to undeveloped environment. Site topography is relatively level, with a slight fall towards the north western boundary. Existing vegetation beyond the north western boundary has been identified identified as a potential bushfire hazard. A lateral offshoot of South Creek divides the eastern portion of the site and the associated remnant vegetation presents an additional bushfire hazard. Consideration must be given to the potential bushfire threat when retaining and rehabilitating the creekline vegetation,

SOIL TYPE

Site soil consists of Warners Bay (wa), as defined by the Department of Land and Water Conservation (Matthei, 1995). The soil landscape comprise moderately deep to deep soils on large slopes with broad crests and drainage lines. These soils are characterised as having a high water erosion, mass movement and foundation hazard and are located within a Mine Subsidence District. They are subject to seasonal waterlogging, with a moderate to high shrink-swell, are of low fertility and strongly acidic. It is possible that former clearing and building works have altered the original soil material, resulting in the existing site soil being of indeterminate horticultural value. It is recommended that excavated site topsoil be tested and ameliorated to a horticultural standard and incorporated into proposed mass planted areas. Should the required standard be unachievable, then imported growing media is recommended.

Site vegetation once consisted of Tall Open Forest containing Corymbia maculata (Spotted Gum), Eucalyptus punctata (Grey Gum), Eucalyptus umbra (Bastard Mahogany), Eucalyptus paniculata (Grey Ironbark) and Corymbia gummifera (Red Bloodwood). Melaleuca spp. (Paperbark), Eucalyptus robusta (Swamp Mahogany) and Casuarina glauca (River Oak) occur in poorly drained areas. Most of these species are still present on site, either as individual specimens or (more commonly) in copses and more prevalent in the less-developed eastern quadrant of the site. A small portion of exotic trees are located within closer proximity to the residences, however the overall impression of the site landscape is that of a native theme. A significant proportion of the sites southern and eastern boundaries are screened by native vegetation, with only small pockets affording unobstructed views into the site. Screening vegetation occurs to a lesser degree along the northern boundary, which, in combination with elevated topography and higher density development along Casson Avenue results in a more significant view catchment. Refer to the Visual Impact Assessment for further discussion.

LANDSCAPE CHARACTER AND VISUAL AMENITY

The Mount Hutton Area Plan describes the Casson Avenue Precinct as comprising "a large area of bushland that forms part of the treed backdrop to the south-west of Mount Hutton. The area may be characterised as bushland and rural housing to the south with undeveloped Local Aboriginal Land Council holdings to the north."

As previously mentioned the site is located within a rural residential setting, surrounded by vegetated hillsides. Although higher density residential development (and a higher proportion of exotic landscape treatment) is present within half a kilometer of the site, the immediate vicinity has a distinctly native landscape character.

landscape design report

Eleebana Shores - Seniors living retirement village development

The greatest visual impact will be experienced by the brick residence located within 50m of the northern boundary. The residence is bounded by open turfed paddocks, minimal trees and no advanced screening shrubs, thus providing open views directly into the site. However there are immature screening shrubs recently planted along the common boundary which will provide privacy to this dwelling. A few residences on Casson Avenue will also experience some visual impact, which due to their higher elevations and intermittent vegetation have a combination of filtered and exposed views across paddocks to the site. However, this should not be considered exclusive of their rural-residential context, which includes of an extensive fencing network and several colorbond sheds in addition to residential dwellings.

Visual access is also expectedly high from vehicles travelling along Burton Road. Existing vegetation currently provides significant screening to Lot 11 and intermittently along the western boundary of Lot 12.

PROPOSED DEVELOPMENT

The proposed development involves the demolition of all existing structures and the construction of an over 55s retirement village. This will consist of 61 new villas as single storey buildings and 40 new apartment within two storey apartment building. The proposed development shall also include a recreational centre which will be located in the eastern quadrant of the site. The proposed works will be set back approximately 10m from Burton Road and extent eastwards, with a significant landscape buffer to the main road interface to retain the rural character.

PROPOSED LANDSCAPE WORKS AND OBJECTIVES

- The landscape objectives include several key elements:
- 1. Retention of existing rural streetscape character and set-back.
- 2. Retention of significant existing vegetation,
- 4. Provide extensive visual screening of the internal development density from both the street and the adjoining properties especially from the north in Casson Ave.
- 5. Extensive internal landscaping areas including common and private open space.
- 6. Pleasing open character to the internal areas of the development including passive garden areas, community spaces, circulatory pathway network, sitting areas and canopy tree planting

The aborist report identifies a large number of trees that are located along the Burton Road boundary that form a row that have a short life expectancy but action will be taken to extend their vigour and life expectancy. This will include the removal of turf grasses around the base and mulching. Complementary tree planting of native species

within the front boundary setback is also proposed with a view to increasing the canopy cover and providing a dense thicket of clear trunks.

The landscape plans shows extensive complementary canopy planting that will significantly exceed the current planted canopy existing on site. Taller native tree plantings throughout ensure that the canopy vegetation continues through the site area rather than just peripheral planting areas The extensive canopy cover shall continue into the site along the main entry road and throughout the overland flowpath connecting to the open around the drainage swale communal recreation areas. Refer to aborist report for further detail.

The access roads entering the site has been provided with a wide landscaped verge to allow extensive mass planting of screening landscape incorporating groundcovers, shrubs and canopy trees. This proposed landscape will provide a visual buffer when looking into the site, effectively screening the internal dwellings from Burton road. The overland flowpaths running north/ south across the site shall contain sandstone spallings along the approximate centreline with mass plantings of native grasses in organic shaped patterns to simulate the flow of water. Upper canopy planting throughout this area shall consist of Melaleuca species to reinforce the impression of a dry creek bed. This theme is continued through the site where drainage easements/ swales occur. When viewed from a distance, this area shall contribute to the existing canopy cover both on site and surrounds, further enhancing the rural character of the area. It also provides a well vegetated visual separation between the front and rear portions of the site, green avenues along two axis, thus increasing the visual amenity upon entering the site.

PROJECT: Eleebana Shores Burton Road, Mt Hutton CLIENT: Elebana Shores Retirement Pty Ltd. 03.6.2014 JOB NUMBER: DRAWN: SCALE: NO. IN SET: REVISION:



landscape design report

02

Eleebana Shores - Seniors living retirement village development

Landscaping to individual units aims to utilise solar access wherever possible to encourage a pleasant outdoor living area. Where rear yards are south-facing an additional deck area is set away from the building adjoined by a small deciduous tree to filter the intensity of summer sun. North facing sitting areas along the street interface shall also be offset with small deciduous trees to permit solar access and contribute to the streetscape. Where possible, drying areas are set away from external living areas and are accessed via large format pavers set into decorative gravel. Slatted screens or trellis systems shall screen the drying areas from outdoor living areas where required

A 5 metre wide vegetated drainage swale with is proposed along the northern boundary. This is an opportunity to provide medium screening shrubs with upper canopy trees to provide filtered screening views from residences further northward of the site along Casson Ave where houses are on higher levels and have potential to view down into the site. The 5m swale with landscaping opportunities to this area allows tree planting to occur using tall endemic species. Tall canopy trees continue the canopy vegetation visible from distant areas. The inclusion of the drainage swale and dwelling locations away from the boundary prevent overshadowing from this landscape. Similar vegetated drainage swale is proposed along the southern boundary with incorporated areas for mass plantings of screening shrubs and tall endemic trees species.

Internal connecting pathways provide pedestrian links between parallel streets and assist in providing casual surveillance to these areas. Central nodal sitting areas points are provided along natural dry creek bed drainage easements, which provides informal meeting places for the residents. Screen planting shall adjoin the building lines, whilst smaller shrubs and grasses are proposed for the foreground to permit casual surveillance along the pathways. Raised pedestrian crossing thresholds are proposed intermittently throughout the site with raised decked seating areas that partially built over the easement providing resting points and informal meeting areas that look over a rural dry creekbed. Trees and low mass planting under with informal bushland walkways shall define these areas.

The eastern quadrant of the site consists of a Exclusion Zone. As no dwellings are permitted within this area, the retention of trees all existing trees will occur. Due to the development remaining oustside of the 40m riparian corridor there will be no impact on the local native vegetation. All planted species to be retained within that zoning.

REFERENCES

Lake Macquarie City Council, 2004, Lake Macquarie Local Environment Plan.

Lake Macquarie City Council, 2008, Lake Macquarie City Development Control Plan No.1,

Principles of Development - Revision 02.

Matthei, L.E, 1995, Soil Landscapes of Newcastle 1:100 000 Sheet Report, Department of Land & Water Conservation, Sydney.

Swain, G.L, 2010, Bushfire Protection Assessment for the Kendal Park Environmental Village (24.03.2010), Australian Bushfire Protection Planners Pty Ltd.

NSW Rural Fire Service, 2006, Planning For Bushfire Protection 2006, A Guide for Councils, Planners, Fire Authorities and Developers, NSW Rural Fire Service.

PROJECT:
Eleebana Shores
SITE:
Burton Road, Mt Hutton
CLIENT:
Elebana Shores Retirement Pty Ltd.
DATE:
03.6.2014
JOB NUMBER:
9861.5
DRAWN:
BJR
SCALE:
N/A
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Eleebana Shores - Seniors living retirement village development



- Burton Road.
 - Existing vegetation screening site's northern boundary.
 - Views across open paddock to site from closest residence.
 - Existing vegetation to site's north east obstructing views into site.
- Filtered views through trees from residence to site's north east.
- 20m riparian zone.
- Single storey residence.
- Filtered views through existing trees into site from Burton Road.
- Dam with overland flow as indicated along internal lot boundaries.

- South Creek.
- Existing vegetation outside of southern boundary obstruct views into site.
- Open views across dam to south of site.
- Ducks Crossing Restaurant.
- Eleebana Childrens Centre.
- Existing native trees.
- Existing exotic trees.
 - Site photo locations (Refer to L04 L05)

PROJECT:

SITE: CLIENT:

DATE:

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NO. IN SET:

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site photos

Eleebana Shores - Seniors living retirement village development

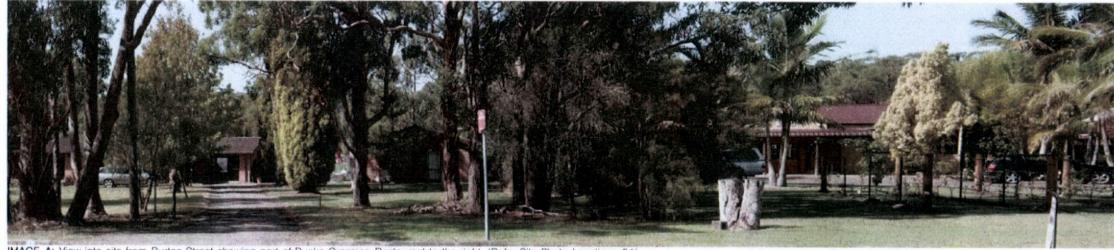


IMAGE A: View into site from Burton Street showing part of Ducks Crossing Restaurant to the right. (Refer Site Photo Locations 01).



IMAGE B: View towards south western boundary from within site indicating screening provided by existing vegetation and boundary fences



IMAGE C: View southwards from within the eastern quadrant of the site indicating the existing dam, some of the sheds and stables.

PROJECT:
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BJR
SCALE:
N/A
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site photos

Eleebana Shores - Seniors living retirement village development



IMAGE D: View north from the approximate centre of the site indicating the exposure of the nearest residence to the site. Note immature screening shrubs planted outside of the subject sites boundary.



IMAGE E: View north from the approximate centre of the site indicating existing horse paddocks and remnant vegetation to the background. Note: Filtered views from residences to the north of the site.



IMAGE F: View east from creekline showing extent of remnant vegetation providing screening from residences. Potential bushfire hazard from this direction to be considered in landscape design.

PROJECT:

SITE:

Burton Road, Mt Hutto

DATE: 03.6.20

JOB NUMBER

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06

Eleebana Shores - Seniors living retirement village development





LEGEND

Existing native trees to be retained.



Existing native trees to be removed.



Existing exotic trees to be removed.






landscape base masterplan

Eleebana Shores - Seniors living retirement village development

rehabilitation works.

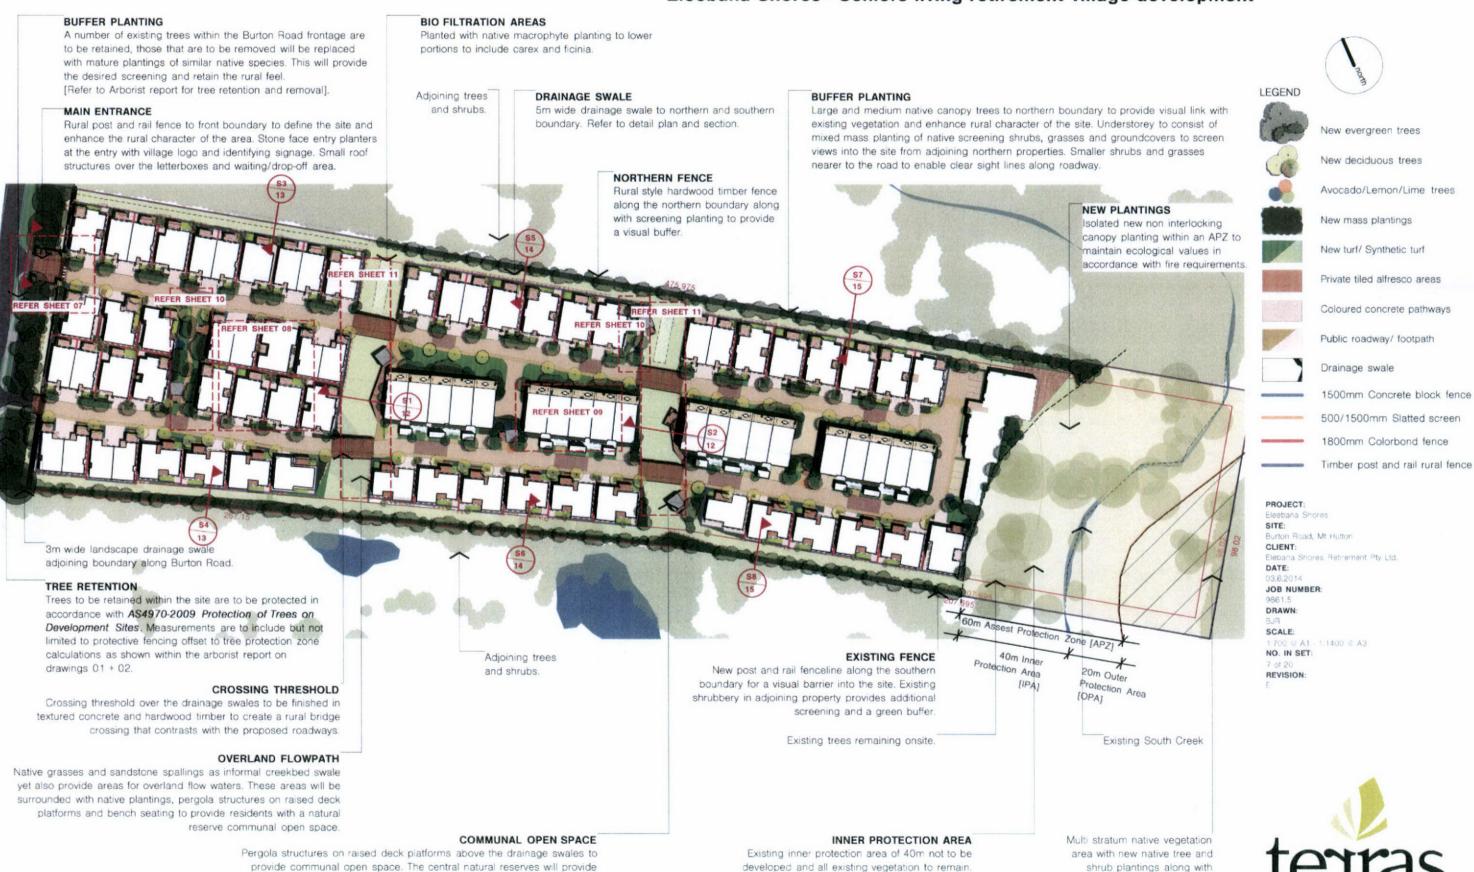

meeting places for residents with seating, nature walks and a variety of

communal fruiting trees like citrus, limes and avocado trees.

entry concept detail

80

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STREET TREE PLANTING

Native canopy trees to front street verge to add additional native screening as well a returning the native vegetation along Burton Road enhancing the local rural character of the development.

BUFFER PLANTING

Existing native canopy trees to front boundary setback. Existing Casuarina species to be retained where posible to keep a native screening on the Burton Road frontage. Planted canopy trees with large and medium native shrubs for additional screening planted either side of the 3m drainage swale which is also planted out with native macrophyte grasses. Planting style is to reflect local rural character of surrounding area.

ENTRY SIGNAGE

Metal lettering raised above groundcover plantings spelling out Eleebana Shores, Approximate height of letters is 600 - 800mm. Fixed to top of rural fenceline.

Undercover banks of letterboxes with temporary mail pickup parking.

MAIN ENTRANCE

Rural post and rail fence to front boundary to define the site and enhance the rural character of the area. Stone face entry planters at the entry with village logo and identifying signage. Small roof structures over the letterboxes and waiting/drop-off area. The surface finish to the entry bridge and other bridges within the development are to be textured concrete or hardwood timber to create a rural bridge crossing that contrasts with the proposed roadways.

BIO FILTRATION AREAS

Planted with native macrophyte planting to lower portions to include carex and ficinia.

Undercover waiting/ drop-off area for residents. The footpath from this location leads to the public bus stop with shelter on Burton Road.



LEGEND



New evergreen trees



New deciduous trees

Avocado/Lemon/Lime trees



New mass plantings



New turf/ Synthetic turf



Private tiled alfresco areas

Coloured concrete pathways



Public roadway/ footpath



Drainage swale



1500mm Concrete block fence



500/1500mm Slatted screen



Timber post and rail rural fence



Eleebana Sho

SITE:

CLIENT:

DATE:

JOB NUMBER:

9861.5 DRAWN:

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typical residential gardens detail

09

Eleebana Shores - Seniors living retirement village development

LAWNS

lawns to residential yards to provide open areas. May include synthetic lawns to small areas within yards.

SMALL TREES

Small evergreen and or deciduous trees where space permits to filter summer sun whilst permitting winter solar access.

COMMON BOUNDARY

1800mm high colorbond fence [shown in red] to common boundaries of these unit types. Due to close proximity of private open spaces and to enable of drying lines to fence.

SOUTHERN STREET TREES

Southern street frontages to have native evergreen trees along roads verge providing an avenue of greenery and provides additional privacy for residents.

STREET CARRIAGEWAY

Opportunity for small street tree plantings along streets carriageway to soften built element of the the residences. Low mass plantings and a strip of turf along the street to ensure sightlines are maintained.

- North

New evergreen trees

New deciduous trees

Avocado/Lemon/Lime trees

New mass plantings

New turf/ Synthetic turf

Private tiled alfresco areas

Coloured concrete pathways

Public roadway/ footpath

Drainage swale

1500mm Concrete block fence

500/1500mm Slatted screen

1800mm Colorbond fence

Timber post and rail rural fence

PROJECT:

SITE:

CLIENT:

Elebana Shores Retirement Pty Lt

DATE: 03.6.2014

JOB NUMBER:

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SCALE: 1:150 @ A1 - 1:300 @ A3

NO. IN SET:

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Oxide coloured concrete pathways set within road verge. 1200mm wide.



Refer to sheet 18 for materials + components images.

COMMON PATHWAYS

NORTHERN DECIDUOUS STREET TREES

NORTHERN OUTDOOR YARDS

REAR YARDS

to have synthetic turf to allocated areas.

Northern street frontages to have medium deciduous trees to provide shade during the summer months yet also

provide sunlight into living spaces in the winter months.

1500mm high front wall that provides private outdoor space for dwellings that face north. Part concrete and

Shade tolerant screening shrubs adjacent to southern

aspect of buildings, with species of a higher sun tolerance

where more exposed. Mature plant height graded from tall

to low for tiered effect when viewed from sitting area, Small

evergreen or deciduous trees where space permits to filter

summer sun whilst permitting winter solar access. Private outdoor space to have synthetic turf to allocated areas.

Small evergreen trees where space permits along northern

side of the road. Trees underplanted with small shrubs and grasses differing to each unit. Synthetic turf used with small grass area to give a green finish with little maintenance.

aluminium slatting to provide part solid and open screening combined with mixed shrub planting. Private outdoor space

typical apartment gardens detail

Eleebana Shores - Seniors living retirement village development

COMMON PATHWAYS

Oxide coloured concrete pathways set within road verge. 1200mm wide.

APARTMENT BALCONY SPACE

Covered balcony areas to all apartments both on bottom + top floors. Balconies look over into mass planted garden and medium to large trees, providing privacy and a green

DRAINAGE SWALE

Small and medium native canopy tree to upper embankment of southern side of the swale, underplanted with native shrubs. Macrophyte planting to lower portions to include carex and ficinia.

CANOPY TREES

Native trees to be planted to on mass in open space areas to replace trees lost during construction. Proposed tree canopy exceeds existing canopy coverage. Trees to be interplanted with mixed native shrubs, grasses and groundcovers.



SOUTHERN STREET TREES

Southern street frontages to have native evergreen trees along roads verge providing an avenue of greenery and provides additional privacy for residents.

STREET CARRIAGEWAY

Opportunity for small street tree plantings along streets carriageway to soften built element of the the residences. Low mass plantings and a strip of turf along the street to ensure sightlines are maintained.

BUFFER PLANTING

Large and medium native canopy trees between the apartment buildings along southern boundary to provide visual link with existing vegetation and enhance rural character of the site. Understorey to consist of mixed mass planting of native screening shrubs, grasses and groundcovers to filter views into the site from adjoining southern property.

VISITOR CARPARKING

Visitor car parking allowed for six car spaces along the street carriageway out the front of the apartment complex.

New evergreen trees



New deciduous trees



Avocado/Lemon/Lime trees



New mass plantings New turf/ Synthetic turf



Private tiled alfresco areas



Coloured concrete pathways



Public roadway/ footpath



Drainage swale



1500mm Concrete block fence 500/1500mm Slatted screen



1800mm Colorbond fence







SITE:

Burton Boad, Mt Hutton CLIENT: Elebana Shores Retirement Pty Ltd.

DATE:

JOB NUMBER:

DRAWN: SCALE:

1:150 @ A1 - 1:300 @ A3 NO. IN SET:

REVISION:



communal areas detail

Eleebana Shores - Seniors living retirement village development

BUFFER PLANTING

Large and medium native canopy trees to northern boundary to provide visual link with existing vegetation and enhance rural character of the site. Understorey to consist of mixed mass planting of native screening shrubs, grasses and groundcovers to filter views into the site from adjoining northern properties. Smaller shrubs and grasses nearer to the road to enable clear sight lines along roadway.

Planted with native macrophyte planting to lower

Pergola structures on raised deck platforms above the drainage swales to provide communal open space. The central natural reserves will provide meeting places for residents with seating, nature walks and a variety of communal fruiting trees like citrus, limes and avocado trees.

CANOPY TREES

Native trees to be planted to on mass in open space areas to replace trees lost during construction. Proposed tree canopy exceeds existing canopy coverage. Trees to be interplanted with mixed native shrubs, grasses and groundcovers.

FENCING

post and rail rural fence giving the feeling a greater

STREET CARRIAGEWAY

Opportunity for small street tree plantings along streets Low mass plantings and or a strip of turf along the street to_

CROSSING THRESHOLD

Crossing threshold over the drainage swales to be finished in textured concrete and hardwood timber to create a rural bridge

COMMON PATHWAYS

Oxide coloured concrete pathways set

OVERLAND FLOWPATH

Native grasses and sandstone spallings as informal creekbed swale yet also provide areas for overland flow waters. These areas will be surrounded with native plantings, pergola structures on raised deck platforms and bench seating to provide residents with a natural reserve communal open space.

BIO FILTRATION AREAS

portions to include carex and ficinia.

COMMUNAL OPEN SPACE

Fencelines adjoining shared open space to be timber connection to the outdoors and overall rural feel within the development.

carriageway to soften built element of the the residences. ensure sightlines are maintained.

crossing that contrasts with the proposed roadways.

within road verge. 1200mm wide.



New evergreen trees

New deciduous trees Avocado/Lemon/Lime trees

New mass plantings

New turf/ Synthetic turf

Private tiled alfresco areas

Coloured concrete pathways Public roadway/ footpath

Drainage swale

1500mm Concrete block fence

500/1500mm Slatted screen 1800mm Colorbond fence

Timber post and rail rural fence

PROJECT:

SITE: CLIENT:

DATE:

JOB NUMBER

DRAWN: SCALE: 1:100 @ A1 - 1:200 @ A3

NO. IN SET: REVISION:







Refer to sheet 18 for materials + components images.

Eleebana Shores - Seniors living retirement village development

BUFFER PLANTING

Large and medium native canopy trees to northern boundary to provide visual link with existing vegetation and enhance rural character of the site. Understorey to consist of mixed mass planting of native screening shrubs, grasses and groundcovers to filter views into the site from adjoining northern properties. Smaller shrubs and grasses nearer to the road to enable clear sight lines along roadway.

COMMUNAL OPEN SPACE

Pergola structures on raised deck platforms above the drainage swales to provide communal open space. The central natural reserves will provide meeting places for residents with seating, nature walks and a variety of communal fruiting trees like citrus, limes and avocado trees.

BIO FILTRATION AREAS

Planted with native macrophyte planting to lower portions to include carex and ficinia.

CROSSING THRESHOLD

Crossing threshold over the drainage swales to be finished in textured concrete and hardwood timber to create a rural bridge crossing that contrasts with the proposed roadways.

CANOPY TREES

Native trees to be planted to on mass in open space areas to replace trees lost during construction.

Proposed tree canopy exceeds existing canopy coverage. Trees to be interplanted with mixed native shrubs, grasses and groundcovers.

FENCING

Fencelines adjoining shared open space to be timber post and rail rural fence giving the feeling a greater connection to the outdoors and overall rural feel within the development.

STREET CARRIAGEWAY

Opportunity for small street tree plantings along streets carriageway to soften built element of the the residences. Low mass plantings and or a strip of turf along the street to ensure sightlines are maintained.

COMMON PATHWAYS

Oxide coloured concrete pathways set within road verge. 1200mm wide.

OVERLAND FLOWPATH

Native grasses and sandstone spallings as informal creekbed swale yet also provide areas for overland flow waters. These areas will be surrounded with native plantings, pergola structures on raised deck platforms and bench seating to provide residents with a natural reserve communal open space.

2 Refer

Refer to sheet 18 for materials + components images.





New evergreen trees

New deciduous trees

Avocado/Lemon/Lime trees

New mass plantings

New turf/ Synthetic turf

Private tiled alfresco areas

Coloured concrete pathways

Public roadway/ footpath

Drainage swale

1500mm Concrete block fence

500/1500mm Slatted screen

1800mm Colorbond fence

Timber post and rail rural fence

PROJECT: Fleebana Shores

SITE:

Burton Road, Mt Huttor CLIENT:

Elebana Shores Retrement Pty Ltd.

03.6.2014 JOB NUMBER:

GRA15

9861.5 DRAWN:

SCALE:

1:200 @ A1 - 1:400 @ A3 NO. IN SET:

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landscape section details 1/2

Eleebana Shores - Seniors living retirement village development

SECTION 01

DRAINAGE SWALE

Small and medium native canopy tree to upper embankment of northern side of the swale, underplanted with native shrubs. Macrophyte planting to lower portions to include carex and ficinia.

SMALL TREES

Small evergreen and or deciduous trees where space permits to filter summer sun whilst permitting winter solar access.

Fencelines adjoining shared open space to be timber post and rail rural fence giving the feeling a greater connection to the outdoors and overall rural feel within

CANOPY TREES

Generally trees to be planted at approximately 4m centres, to encourage strong upright growth. Trees to be interplanted with mixed native shrubs.

COMMUNAL OPEN SPACE

Pergola structures on raised deck platforms above the drainage swales to provide communal open space. The central natural reserves will provide meeting places for residents with seating, nature walks and a variety of communal fruiting trees like citrus, limes and avocado trees.

APARTMENT BALCONY SPACE

Covered balcony areas to all apartments both on bottom + top floors. Balconies look over into mass planted swale and gardens wit medium to large trees, providing privacy and a green outlook.

SECTION 02

VILLA RESIDENCE

LANDSCAPED EDGE

CANOPY TREES

Generally trees to be planted at approximately 4m centres, to encourage strong upright growth. Trees to be interplanted with mixed native shrubs.

APARTMENT BALCONY SPACE

Covered balcony areas to all apartments both on bottom + top floors. Balconies look over into mass planted swale and gardens wit medium to large trees, providing privacy and a green outlook.

DRAINAGE SWALE

Small retaining wall made of sandstone stacking blocks along the northern boundary that adjoins the swale with large screening shrubs to edge and macrophyte plantings within basin of swale.



BIO RETENTION ZONE

15.5M PLANTED

DRAINAGE SWALE

LANDSCAPED EDGE APARTMENT COMPLEX TREATMENT

15.5M PLANTED

BUFFER PLANTING

Large and medium native canopy trees between the apartment buildings to provide visual link with surrounding existing vegetation and enhance rural character of the site. Understorey to consist of mixed mass planting of native screening shrubs, grasses and groundcovers to filter views into apartment residences from street carrieway.

COMMUNAL OPEN SPACE

Pergola structures on raised deck platforms above the drainage swales to provide communal open space. The central natural reserves will provide meeting places for residents with seating, nature walks and a variety of communal fruiting trees like citrus, limes and avocado trees.

OVERLAND FLOWPATH

Native grasses and sandstone spallings as informal creekbed swale yet also provide areas for overland flow waters. These areas will be surrounded with native plantings, pergola structures on raised deck platforms and bench seating to provide residents with a natural reserve communal open

PROJECT:

SITE:

Burton Road, Mt Hutten

CLIENT:

DATE:

JOB NUMBER

DRAWN

SCALE:

1:75 @ A1 - 1:150 @ A3 NO. IN SET:

REVISION:



SECTION 03

COMMON BOUNDARY

1800mm high colorbond fence where common side boundary adjoins drying area: to screen and facilitate fixing of drying lines. Timber post and rail fence to remainder of common boundary to reflect the rural theme of the locality.

REAR YARD PLANTINGS

Small deciduous feature tree as accent point when viewed from private open space. Underplanted with mixed shrubs, grasses, groundcovers and accents plantings taken from planting schedules.

DRAINAGE SWALE

Small retaining wall made of sandstone stacking blocks along the northern boundary that adjoins the swale with large screening shrubs to edge and macrophyte plantings within basin of swale.



NORTHERN BOUNDARY

New post and rail fenceline to be installed along northern boundary, so as to permit views from adjacent residences into the revegetated drainage swale. Large screening shrubs towards the boundary line to create a green screen when viewed from northern adjoining properties.

DRAINAGE SWALE

NEIGHBOURING

Small and medium native canopy tree to upper embankment of northern side of the swale, underplanted with native shrubs. Macrophyte planting to lower portions to include carex and ficinia.

SECTION 04

CANOPY TREES


Generally trees to be planted at approximately 4m centres, to encourage strong upright growth. Trees to be interplanted with mixed native shrubs.

SOUTHERN BOUNDARY

New post and rail fenceline to be installed along southern boundary, so as to retain privacy from adjacent residences into the revegetated drainage swale. Large screening shrubs towards the boundary line to create a green screen when viewed from southern adjoining properties.

DRAINAGE SWALE

Small and medium native canopy tree to upper embankment of southern side of the swale, underplanted with native shrubs. Macrophyte planting to lower portions to include carex and ficinia.

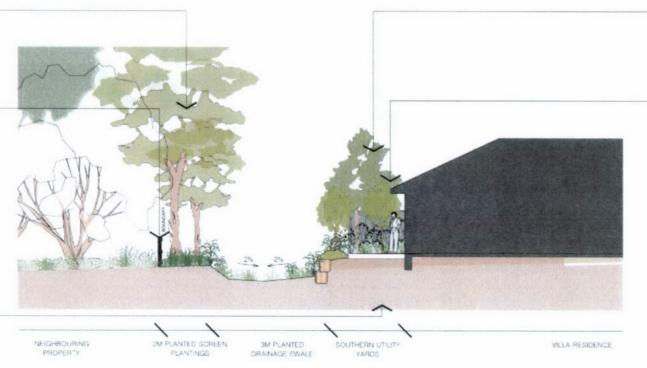

SOUTHERN NATIVE TREES

Southern swale frontages to have medium native trees to provide added screening to the property and to add to the

SOUTHERN UTILITY YARDS

Rear gardens of southern properties generally have small outdoor living spaces as the major exterior living areas are positioned on the northerly position of the residence. Rear gardens to contain clothes line and water tanks.

PROJECT:

rton Road, Mt Hutton CLIENT:

DATE:

JOB NUMBER

DRAWN

SCALE:

1:75 @ A1 - 1:150 @ A3 NO. IN SET:

REVISION



Eleebana Shores - Seniors living retirement village development

SECTION 05

COMMON BOUNDARY


1800mm high colorbond fence where common side boundary adjoins drying area: to screen and facilitate fixing of drying lines. Timber post and rail fence to remainder of common boundary to reflect the rural theme of the locality.

REAR YARD PLANTINGS

Small deciduous feature tree as accent point when viewed from private open space. Underplanted with mixed shrubs, grasses, groundcovers and accents plantings taken from planting schedules.

DRAINAGE SWALL

Small retaining wall made of sandstone stacking blocks along the northern boundary that adjoins the swale with large screening shrubs to edge and macrophyte plantings within basin of swale.

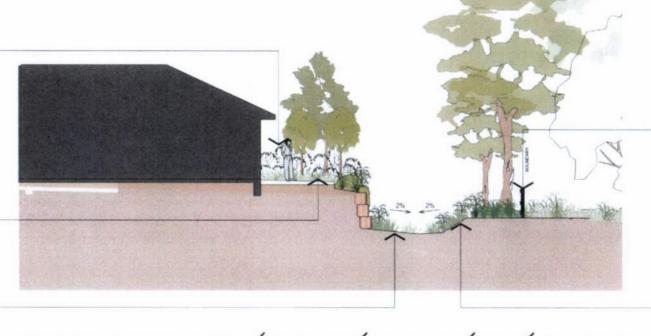

PLANTINGS

NORTHERN BOUNDARY

New post and rail fenceline to be installed along northern boundary, so as to permit views from adjacent residences into the revegetated drainage swale. Large screening shrubs towards the boundary line to create a green screen when viewed from northern adjoining properties.

DRAINAGE SWALE

Small and medium native canopy tree to upper embankment of northern side of the swale, underplanted with native shrubs. Macrophyte planting to lower portions to include carex and ficinia.

SECTION 06

VILLA RESIDENCE

CANOPY TREES


Generally trees to be planted at approximately 4m centres, to encourage strong upright growth. Trees to be interplanted with mixed native shrubs.

SOUTHERN BOUNDARY

New post and rail fenceline to be installed along southern boundary, so as to retain privacy from adjacent residences into the revegetated drainage swale. Large screening shrubs towards the boundary line to create a green screen when viewed from southern adjoining properties.

DRAINAGE SWALE

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SOUTHERN NATIVE TREES
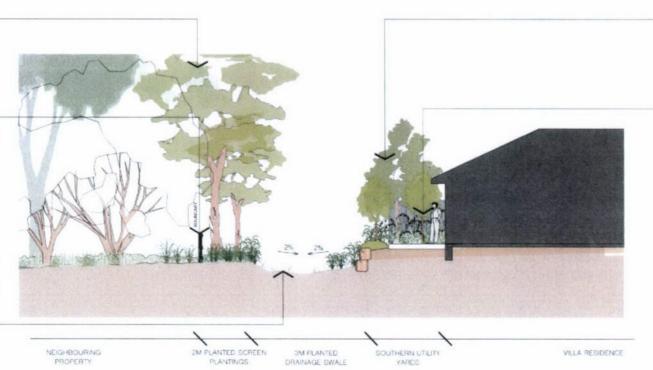
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SOUTHERN UTILITY YARDS

Rear gardens of southern properties generally have small outdoor living spaces as the major exterior living areas are positioned on the northerly position of the residence. Rear gardens to contain clothes line and water tanks.

PROJECT:

SITE:

Burton Road, Mt Hutton CLIENT:

debana S

DATE:

JOB NUMBER

9861.5

DRAWN:

SCALE: 1:75 @ A1 - 1:150 @ A3

NO. IN SET:

REVISION



Eleebana Shores - Seniors living retirement village development

SECTION 07

COMMON BOUNDARY

1800mm high colorbond fence where common side boundary adjoins drying area: to screen and facilitate fixing of drying lines. Timber post and rail fence to remainder of common boundary to reflect the rural theme of the locality.

REAR YARD PLANTINGS

Small deciduous feature tree as accent point when viewed from private open space. Underplanted with mixed shrubs, grasses, groundcovers and accents plantings taken from planting schedules.

DRAINAGE SWALE

Small retaining wall made of sandstone stacking blocks along the northern boundary that adjoins the swale with large screening shrubs to edge and macrophyte plantings within basin of swale.

VILLA RESIDENCE NORTHERN OUTDOOR 5M PLANTED 2M PLANTED SCREEN NEIGHBOURING

NORTHERN BOUNDARY

New post and rail fenceline to be installed along northern boundary, so as to permit views from adjacent residences into the revegetated drainage swale. Large screening shrubs towards the boundary line to create a green screen when viewed from northern adjoining properties.

DRAINAGE SWALE

Small and medium native canopy tree to upper embankment of northern side of the swale, underplanted with native shrubs. Macrophyte planting to lower portions to include carex and ficinia.

SECTION 08

CANOPY TREES


Generally trees to be planted at approximately 4m centres, to encourage strong upright growth. Trees to be interplanted with mixed native shrubs.

SOUTHERN BOUNDARY

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Small and medium native canopy tree to upper embankment of southern side of the swale, underplanted with native shrubs. Macrophyte planting to lower portions to include carex and ficinia.



SOUTHERN NATIVE TREES

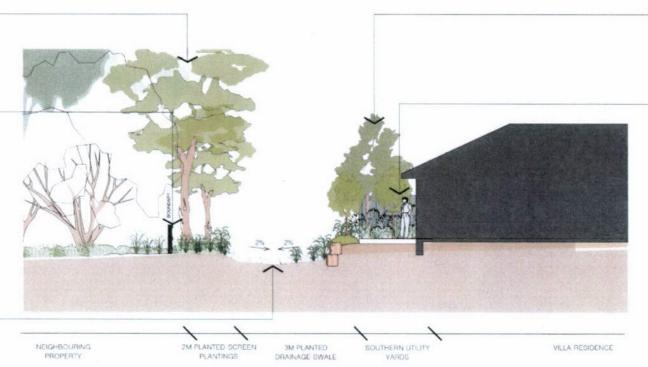Southern swale frontages to have medium native trees to provide added screening to the property and to add to the rural surrounds.

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Rear gardens of southern properties generally have small outdoor living spaces as the major exterior living areas are positioned on the northerly position of the residence. Rear gardens to contain clothes line and water tanks.

PROJECT:

SITE:

Burton Road, Mt Hutton CLIENT:

Jebaha S

DATE:

JOB NUMBER

DRAWN:

SCALE:

1:75 @ A1 - 1:150 @ A3


NO. IN SET: 16 of 20





proposed fencing plan

Eleebana Shores - Seniors living retirement village development

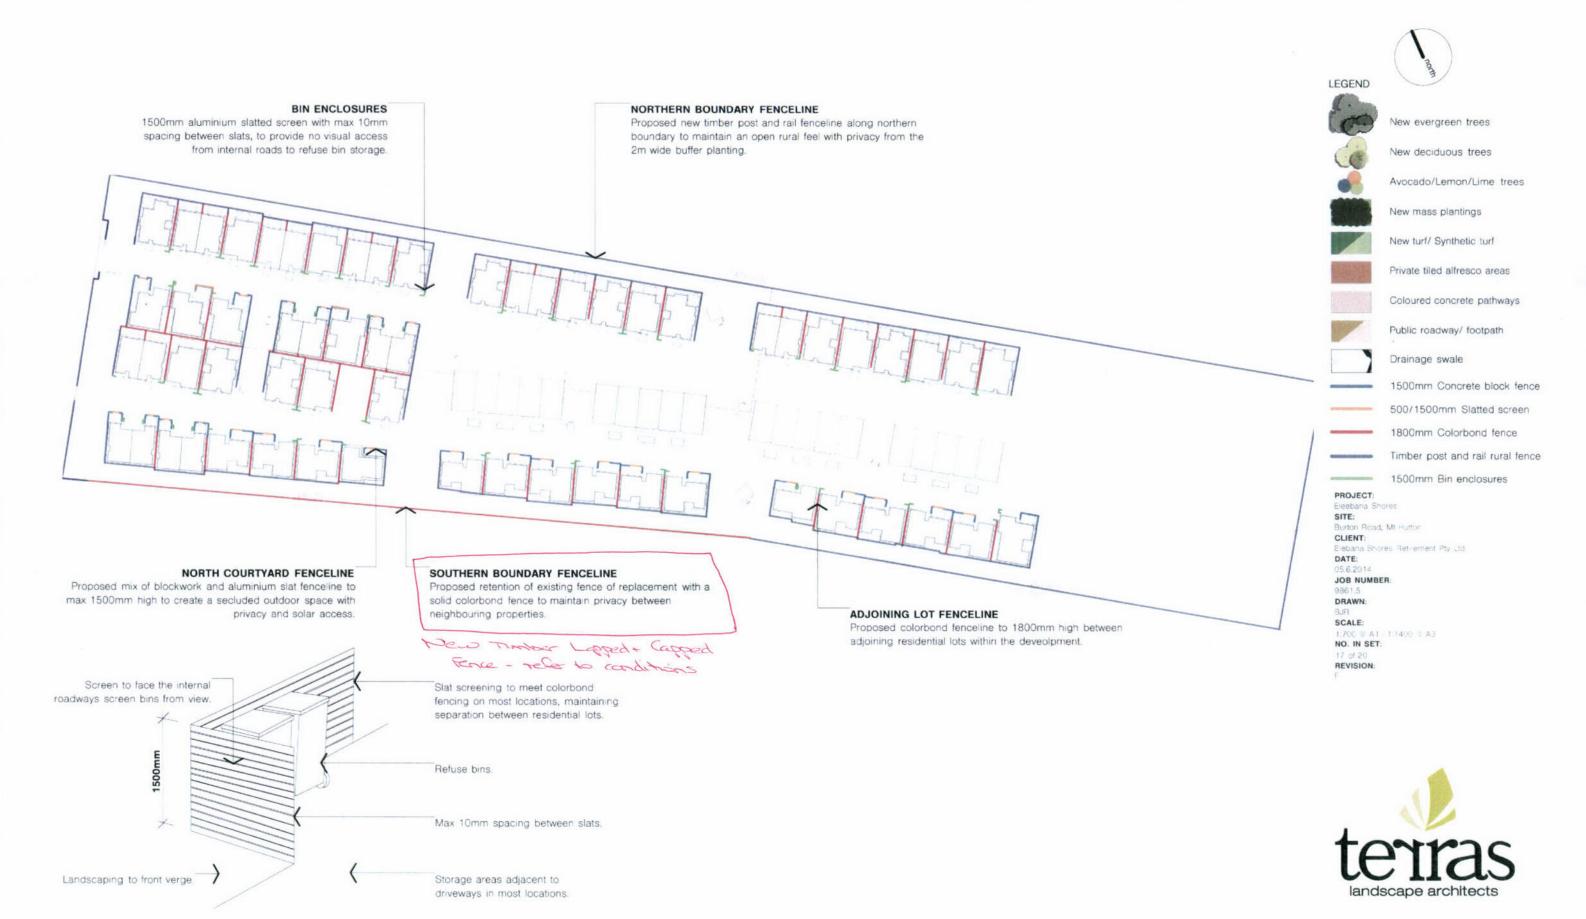

common area planting schedules 18

Eleebana	Shores -	Seniors	living	retirement	village	development
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PLANT	SCHEDULE - OVERLAND FLOWP	ATH, BOUNDARY + SETBACK	S		PLANT	SCHEDULE - FRONT GARDENS + S	TREET TREES		
ABV TREES	BOTANICAL NAME	COMMON NAME	POT SIZE	MATURE SIZE	ABV TREES	BOTANICAL NAME	COMMON NAME	POT SIZE	MATURE SIZ
AC	Angophora costata	Smooth Barked Apple	45 litre	25 x 6m	CR	Corymbia 'Summer Red'	Dwarf Red Eucalyptus	75 litre	5 x 2.5m
CR	Casuarina glauca	Swamp Oak	45 litre	20 x 6m	LO	Liquidambar orientalis	Dwarf Liquidambar	75 litre	10 x 5m
CM	Corymbia maculata	Spotted Gum	45 litre	25 x 7m	LI	Lagerstroemia indica	Crepe Myrtle	™Z5 litre	4 x 4m
EG	Eucalyptus gummifera	Red Bloodwood	45 litre	25 x 7m	PY	Pyrus 'Capital'		√∞ Z5 litre	11 x 3m
EM	Eucalyptus microcorys	Tallowood	45 litre	35 x 8m	SA	Syzygium australe 'Pinnacle'		75 litre	3 x 1.5m
EP	Eucalyptus punctata	Grey Gum	45 litre	30 x 8m	TL	Tristaniopsis laurina 'Luscious'		∞ 75 litre	9 x 4m
EU	Eucalyptus umbra	Bastard Mahogany	45 litre	25 x 8m	WF	Waterhousia floribunda		≈ 75 litre	10 x 5m
MQ	Melaleuca quinquenervia	Broad Leaved Paperbark	45 litre	9 x 5m	****	Waternedsia nonbanda	Weeping Liny Finy	70 mile	10 X 3111
TL	Tristaniopsis laurina	Water Gum	45 litre	10 x 4m	FRUITIN	IG TREES			
. —			10 110		-	Persea americana	Avocado tree	25 litre	
						Citrus aurantifolia	Tahitian Lime	25 litre	
SHRUB	S				-	Citrus × Iimon	Lemon Tree	25 litre	
Ac	Acacia spp.	Wattle	5 litre	Variable		on do milon	Lomon Tree	20 1110	
Am	Acmena spp.	Dwarf Lilly Pilly	5 litre	Variable	SHRUBS	S			
Bs	Banksia spp.	Banksia	5 litre	Variable	Ah	Acmena 'Hot Flush'	Dwarf Lilly Pilly	5 litre	3 x 1.5m
Ca	Callistemon spp.	Bottlebrush	5 litre	Variable	Bb	Banksia 'Birthday Candles'	Dwarf Banksia	2.5 litre	0.45 x 0.65n
De	Doryanthes excelsa	Gymea Lily	5 litre	2m	Cd	Callistemon 'Captian Cook'	Dwarf Bottlebrush	5 litre	1.5 x 1.2m
Ms	Melaleuca spp.	Paperbark	5 litre	Variable	Cs	Camellia sasangua 'White'	Camellia	5 litre	3 x 1.5m
Sy	Syzygium sp & cvs	Lilly Pilly	5 litre	Variable	Ga	Gardenia augusta 'Florida'	Gardenia	5 litre	1.5 x 1.2m
Wz	Westringia cvs	Coast Rosemary	2.5 litre	Variable	Gr	Grevillea 'Robyn Gordon'	Grevillea		
***	Westingia CVS	Coast Hosemary	2.5 1116	Variable	Mf	Michelia figo	Port Wine Magnolia	2.5 litre 5 litre	1.5 x 1.2m 4 x 3.5m
					Mp	Murraya paniculata	Murraya	5 litre	4 x 3.5m
GRASS	FS				Mt	Metrosideros 'Tahiti'	Dwarf NZ Christmas Bu		
Ca	Carex appressa	Tussock Sedge	viro tube	1 x 1m	Ro	Raphiolepis 'Oriental Pearl'	Dwarf Indian Hawthorn	2.5 litre	1 x 0.8m 1 x 0.8m
In	Isolepis nodosa	Knobby Club Rush	viro tube	1 x 1m Density	Sc	Syzygium 'Cascade'	Dwarf Lilly Pilly		2.5 x 1.5m
Ju	Juncus usitatus	Common Rush	viro tube	0.8 x 0.7m	Vo	Viburnum odoratissimum Emerald Lustr		5 litre	
LI	Lomandra longifolia	Mat Rush	2.5 litre	1 x 1m	Wz	Westringia 'Zena'	Dwarf Coast Rosemary	5 litre	4.5 x 2m
Lt	Lomandra 'Tanika'	Dwarf Mat Rush	2.5 litre	0.8 x 0.7m Condition	VVZ	Westingia Zena	Dwari Coast Rosemary	2.5 litre	0.8 x 0.8m
Sv	Schoenoplectus validus	River Clubrush	viro tube	1.2 x 1m					
OV	Schoenopiecius validus	Aiver Clubiusii	VII O TODE	1.2 X 1111	ACCEN	Te			
					Ca	Cordyline australis 'Sundance'	Condition	4 F 134	0 1 0
GROUN	IDCOVERS					Cycas revoluta	Cordyline	15 litre	2 x 1.2m
Hs	Hibbertia scandens	Guinea Flower	2.5 litre		Cy De	Doryanthes excelsa	Cycad	15 litre	1.5 x 1.2m
Hv	Hardenbergia violacea	False Sasparilla	2.5 litre		Pt		Gymea Lily	15 litre	1.5 x 1.5m
Kr	Kennedia rubicinda	Red Kennedy Pea	2.5 litre		Mc	Phormium tenax	NZ Flax	5 litre	1.5 x 1.2m
Pp	Pandorea pandorana	Wonga Wonga Vine	2.5 litre	*	IVIC	Macrozamia communis	Burrawang	15 litre	1.5 x 1.5m
PP	randorea pandorana	vvonga vvonga vine	Z.5 litre						
					GRASSI	ES			
MEDIUN	M ACCENT				Ap	Agapanthus praecox	Agapanthus	2.5 litre	0.4 x 0.4m
Ae	Aspidistra elatior	Cast Iron Plant	2.5 litre	0.6 x 0.5m	Lm	Liriope 'Evergreen Giant'	Lily Turf	2.5 litre	0.6 x 0.4m
An	Asplenium nidus	Bird's Nest Fern	2.5 litre	0.75 x 1.2m	Lg	Libertia grandiflora	NZ Satin Flower	2.5 litre	0.5 x 1m
Bs	Blechnum 'Silver Lady'	Water Fern	2.5 litre	0.9 x 0.7m					0.0.12.1111
Cc	Cordyline cvs	Cordyline	2.5 litre	Variable					
Px	Philodenron 'Xanadu'	Dwarf Philodendron	2.5 litre	0.5 x 0.5m	GROUN	IDCOVERS			
				7.5.11.518.11	Ar	Ajuga reptans 'Catlins Giant'	Giant Bugle	2.5 litre	
					Мр	Myoporum parvifolium 'Fine Leaf Form'		2.5 litre	
GROUN	IDCOVERS				Jo	Juniperus conferta	Shore Juniper	2.5 litre	
Aj	Ajuga reptans 'Catlins Giant'	Giant Bugle	2.5 litre		Tj	Trachelospermum jasminoides	Star Jasmine	2.5 litre	
Oj	Ophiopogon japonicus	Mondo Grass	2.5 litre		Vo	Viola hederacea	Native Violet	2.5 litre	
Vo	Viola hederacea	Native Violet	2.5 litre			TOWN TOWN ADDRESS TO THE PARTY OF THE PARTY	TOUTO VIOIGE	2.0 1111 6	
204									

PROJECT: Eleebana Shores SITE; Burton Road, Mt Hutton CLIENT: Elebana Shores Retirement Pty Ltd. 9861.5 DRAWN: SCALE: NO. IN SET: REVISION:



PLANT :	SCHEDULE - REAR YARD TYPE 1 -	SHADE		
ABV TREES	BOTANICAL NAME	COMMON NAME	POT SIZE	MATURE SIZE
AP	Acer palmatum 'Sango Kaku'	Japanese Maple	75 litre	6 x 4.5m
CR	Corymbia 'Summer Red'	Dwarf Red Eucalyptus	75 litre	5 x 2.5m
EL	Elaeocarpus reticulatus	Blueberry Ash	25 litre	7 x 3m
HF		Native Franipanni	25 litre	7 x 3m
	Hymenosporum flavum	Statement and Child and the Commence of the Co		Total district
LI	Lagerstroemia indica	Crepe Myrtle	75 litre	4 x 4m
MG	Magnolia grandiflora	Little Gem	25 litre	6 x 4m
TL	Tristaniopsis laurina 'Luscious'	Water Gum	75 litre	9 x 4m
LARGE	SHRUBS			
Ah	Acmena 'Hot Flush'	Dwarf Lilly Pilly	5 litre	3 x 1.5m
Cs	Camellia sasangua	Camellia	5 litre	4 x 1.5m
Mp	Murraya paniculata	Murraya	5 litre	4 x 2m
Sc	Syzygium 'Cascade'	Dwarf Lilly Pilly	5 litre	2.5 x 1.5m
00	Sylygian Sussaids	Drian Emy 1 my	o muo	2.0 X 1.0///
MEDIUN	M SHRUBS			
Ah	Acmena 'Hedgemaster'	Dwarf Lilly Pilly	5 litre	1.5 x 1m
Ct	Choysia ternata	Mexican Orange Blossom	5 litre	1.5 x 1.5m
Ga	Gardenia augusta 'Florida'	Gardenia	5 litre	1.5 x 1.2m
Hm	Hydrangea macrophylla	Hydrangea	5 litre	1.2 x 1.2m
Lc	Loropetalum chinense	Fringe Flower	5 litre	1.8 x 1.5m
	SHRUBS			
Aa	Acmena 'Allyn Magic'	Dwarf Lilly Pilly	2.5 litre	$0.5 \times 0.5 m$
Bm	Buxus microphylla var. microphylla	Dwarf Box	2.5 litre	$0.3 \times 0.3 m$
Cd	Camellia sasanqua 'Dwarf'	Dwarf Camellia	2.5 litre	1 x 0.5m
Cc	Coprosma cvs	Mirror Plant	2.5 litre	1.5 x 1.2m
In	Impatiens 'New Guinea Hybrids'	Hybrid Impatiens	2.5 litre	$0.4 \times 0.4 \text{m}$
Ng	Nandina 'Gulf Stream'	Dwarf Sacred Bamboo	2.5 litre	0.75 x 0.4m
LARGE	ACCENT			
Am	Acanthus molis	Oyster Plant	5 litre	1.2 x 1m
Ca	Cordyline australis 'Sundance'	Cordyline	5 litre	2 x 1.2m
Су	Cycas revoluta	Cycad	15 litre	1.5 x 1.2m
Су	Cycas revoluta	Cycad	15 1146	1.5 X 1.2111
MEDIUN	M ACCENT			
Ae	Aspidistra elatior	Cast Iron Plant	2.5 litre	$0.6 \times 0.5 m$
An	Asplenium nidus	Bird's Nest Fern	2.5 litre	0.75 x 1.2m
Bs	Blechnum 'Silver Lady'	Water Fern	2.5 litre	0.9 x 0.7m
Cc	Cordyline cvs	Cordyline	2.5 litre	Variable
Px	Philodenron 'Xanadu'	Dwarf Philodendron	2.5 litre	$0.5 \times 0.5 m$
01/11	1005117			
THE RESERVE TO SERVE	ACCENT	New Control	regress Sec.	
Cm	Clivea miniata	Clivea	2.5 litre	$0.4 \times 0.3 \text{m}$
Bn	Blechnum nudum	Water Fern	2.5 litre	$0.4 \times 0.3 \text{m}$
Lm	Liriope muscari	Lily Turf	2.5 litre	0.3 x 0.3m
GROUN	NDCOVERS			
Aj	Ajuga reptans 'Catlins Giant'	Giant Bugle	2.5 litre	
Oj	Ophiopogon japonicus	Mondo Grass	2.5 litre	
Vo	Viola hederacea	Native Violet	2.5 litre	
VO	viola lieueracea	realive violet	2.5 iiiie	

residential planting schedules

Eleebana Shores - Seniors living retirement village development

ABV	SCHEDULE - REAR YARD TYPE 1 - S	COMMON NAME	DOT CITE	MATURE OF
TREES	BOTANICAL NAME	COMMON NAME	POT SIZE	MATURE SI
AP	Acer palmatum 'Sango Kaku'	Japanese Maple	75 litre	6 x 4.5m
CR	Corymbia 'Summer Red'	Dwarf Red Eucalyptus	75 litre	5 x 2.5m
EL	Elaeocarpus reticulatus	Blueberry Ash	25 litre	7 x 3m
HF	Hymenosporum flavum	Native Franipanni	25 litre	7 x 3m
LI	Lagerstroemia indica	Crepe Myrtle	75 litre	4 x 4m
MG	Magnolia grandiflora	Little Gem	25 litre	6 x 4m
TL	Tristaniopsis laurina 'Luscious'	Water Gum	75 litre	9 x 4m
ARGE	SHRUBS			
Ah	Acmena 'Hot Flush'	Dwarf Lilly Pilly	5 litre	3 x 1.5m
Cd	Callistemon 'Dawson River Weeper'	Weeping Bottlebrush	5 litre	4 x 2m
Mf	Michelia figo	Port Wine Magnolia	5 litre	4 x 3.5m
Мр	Murraya paniculata	Murraya	5 litre	4 x 2m
Sc	Syzygium 'Cascade'	Dwarf Lilly Pilly	5 litre	2.5 x 1.5m
Vo	Viburnum odoratissimum Emerald Lustre		5 litre	4.5 x 2m
MEDIUN Ab	A SHRUBS Abelia x grandiflora 'Francis Mason'	Golden Abelia	2.5 litre	1.8 x 1.5m
	· 사용 100 전에 가는 100 전에 가는 100 전에 가는 100 전에 되었다. 그렇게 되었다면 가는 100 전에 가는 1			1.5 x 0.9m
Br Co	Banksia ericifolia 'Little Eric'	Dwarf Banksia	2.5 litre	
Cc	Callistemon 'Captain Cook' Echium candicans	Dwarf Bottlebrush	2.5 litre	1.5 x 1.2m
Ec		Pride Of Madiera	2.5 litre	1.5 x 1.5m
Hr	Hibiscus rosa-sinensis	Hibiscus	2.5 litre	2 x 1.5m
Lc	Loropetalum chinense	Fringe Flower	5 litre	1.8 x 1.5m
LIAMS	SHRUBS			
Bm	Buxus microphylla var. microphylla	Dwarf Box	2.5 litre	0.3 x 0.3m
Cc	Coprosma cvs	Mirror Plant	2.5 litre	1.5 x 1.2m
ls	Ixora chinensis	Prince of Orange	2.5 litre	1 x 0.7m
Rc	Raphiolepis cvs	Dwarf Indian Hawthorn	2.5 litre	1 x 0.7m
	Nandina 'Gulf Stream'	Dwarf Sacred Bamboo	2.5 litre	
Ng Wz	Westringia 'Zena'	Dwarf Coast Rosemary	2.5 litre	0.75 x 0.4n 0.8 x 0.8m
LARGE	ACCENT			
Ca	Cordyline australis 'Sundance'	Cordyline	15 litre	2 x 1.2m
Су	Cycas revoluta	Cycad	15 litre	1.5 x 1.2m
De	Doryanthes excelsa	Gymea Lily	15 litre	1.5 x 1.5m
Pt	Phormium tenax	NZ Flax	5 litre	1.5 x 1.2m
Mc	Macrozamia communis	Burrawang	15 litre	1.5 x 1.5m
MEDILI	M ACCENT			
		Agananthus	2.5 litre	0.4 x 0.4m
Ap	Agapanthus praecox	Agapanthus		
Cc	Cordyline 'Red Sensation'	Dwarf Red Cordyline	2.5 litre	1 x 1m
Lm	Liriope 'Evergreen Giant'	Lily Turf	2.5 litre	0.6 x 0.4m
Lg	Libertia grandiflora	NZ Satin Flower	2.5 litre	0.5 x 1m
Px	Philodenron 'Xanadu'	Dwarf Philodendron	2.5 litre	0.5 x 0.5m
SMALI	ACCENT			
Lm	Liriope muscari	Lily Turf	2.5 litre	0.3 x 0.3m
Pb	Phormium 'Bronze Baby'	Dwarf NZ Flax	2.5 litre	0.5×0.3 m
	IDCOVERS		2.32	
Mp	Myoporum parvifolium 'Fine Leaf Form'		2.5 litre	
t -	Juniperus conferta	Shore Juniper	2.5 litre	
JC	damparaa damaraa	Chick a drink of	L.O IIIIO	

PROJECT:
Eleabana Shores
SITE:
Burton Road, Mt Hutton
CLIENT:
Elebana Shores Retirement Pty Ltd.
DATE:
03.6.2014
JOB NUMBER:
9861.5
DRAWN:
BJR
SCALE:
N/A
NO. IN SET:
19 of 20
REVISION:



materials + components

Eleebana Shores - Seniors living retirement village development



